


DRAWING NOTES

- ① 12" CMU WALL W/ #5 BAR @ 32" OC, GOUT SOLID
- ② CONT. L5x3x1/4 (LLH) W/ 1/2" Ø CONC. ANCHORS @ 36" OC.
- ③ HORIZONTAL UPLIFT BRIDGING PLACED @ FIRST PANEL POINT OF BOTTOM CHORD ONLY EACH END
- ④ BRG. L4x4x3/8x0-9" W/ (2) 1/2" Ø CONC. ANCHORS
- ⑤ CONT. L3x3x3/8 FILED WELDED TO STEEL JOISTS
- ⑥ 1/2"x20 GA. TYPE 'B' WIDE-RIB METAL ROOF DECK
- ⑦ 2 1/2" CONC. SLAB ON 3/16"x26 GA. COMP. DECK (3" TOTAL) W/ 6x6-W2.9xW2.9 WWF MESH
- ⑧ HORIZONTAL BRIDGING PER SJI SPECIFICATIONS

ROOF FRAMING PLAN
SCALE: 1/4" = 1'-0"

LINTEL SCHEDULE				
MARK NO.	LINTEL SIZE	MAX OPENING SIZE	BEARING	REINF
①	3x8 BOND BEAM	4'-0" MAX	4" MIN EACH END	(2)#4 BOTT
②	3x16 BOND BEAM	12'-0" MAX	8" MIN EACH END	(2)#5 TOP & BOTT

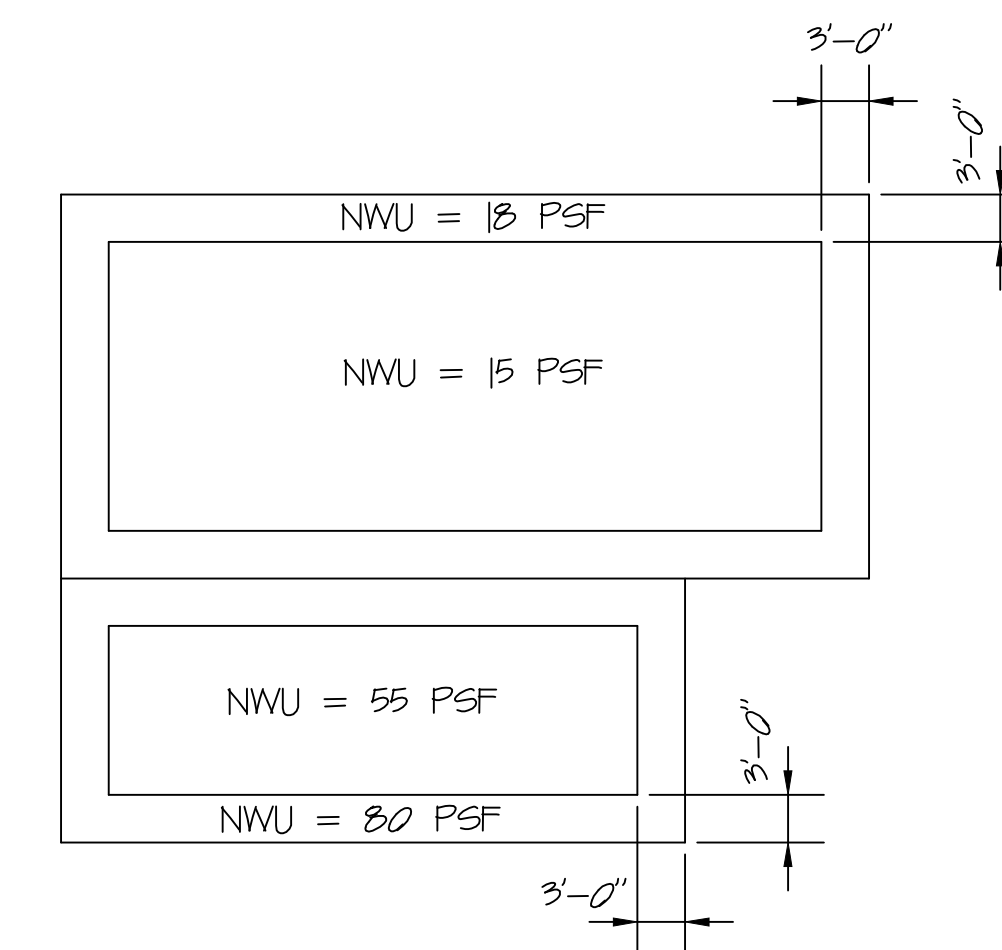

JOIST NET WIND UPLIFT



ASG LLC
AMERICAN STRUCTURAL GROUP
CONSULTING STRUCTURAL ENGINEERS
225 SOUTH MAIN STREET
MONROE, OHIO 45050
WWW.ASGENGIN.COM
"Value Engineering the First Time"

REV	DESCRIPTION	DATE
6		04.28.20
5		
4		
3		
2		
1	PERMIT	
0		

CLIENT: **MSE OF KENTUCKY, INC.**
624 Wellington Way
Lexington, KY 40503
PH: (859)223-5694

PROJECT: **ROMAN COUNTY AMBULANCE GARAGE**
Morehead, Kentucky

CUSTOMER JOB NO.: 5070-02
CUSTOMER: MSE
DRAWN BY: GSM
DATE: 04.20.20
CKD. BY: TSM
DATE: DATE
ASS JOB NO.: 20193
DRAWING FILENAME: 193S1
DRAWING NO: